





FRONT ELEVATION



REAR ELEVATION

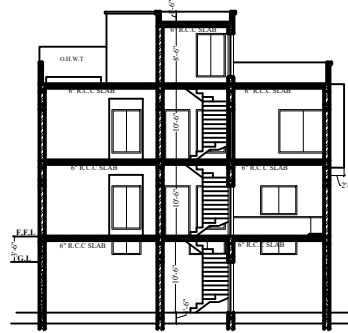


SECTION AT A-A

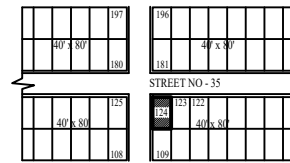


KEY PLAN




M.BLOCK PLAN

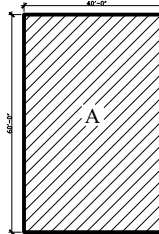


B.BLOCK PLAN

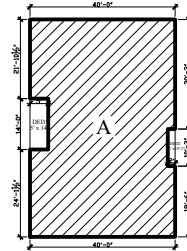


F.BLOCK PLAN

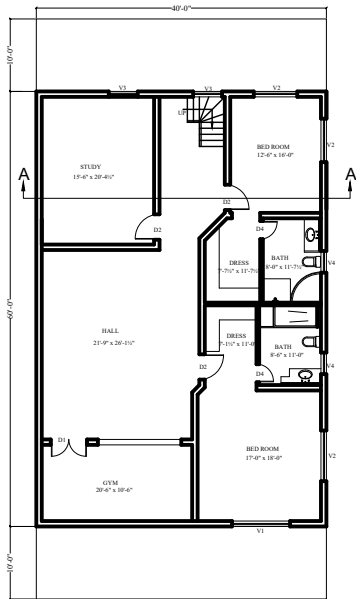


BASEMENT PLAN

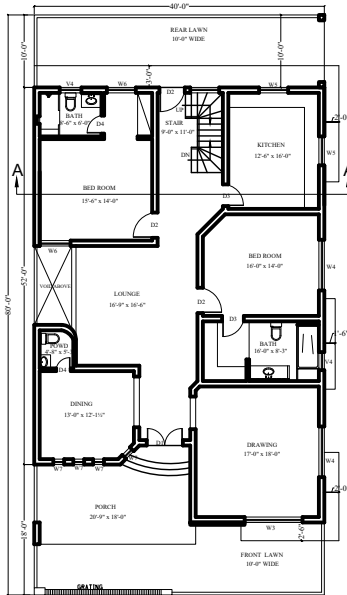


GROUND FLOOR PLAN

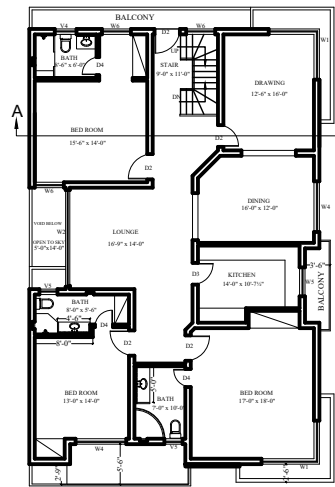

FIRST FLOOR PLAN

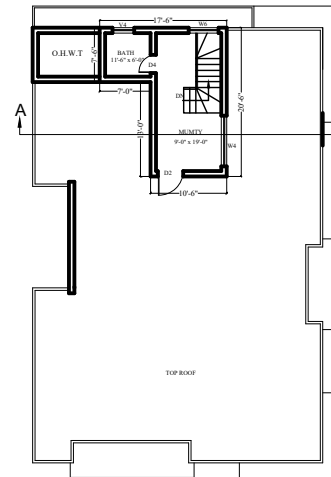

ROOF PLAN

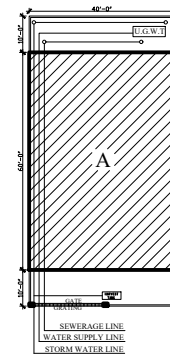

SITE PLAN

SCHEDULE OF AREA

TOTAL PLOT AREA - 40'-0" x 80'-0" = 3200.00 SFT
BASEMENT COVERED AREA - 2400.00 SFT
A - 40'-0" x 66'-0" = 2400.00 SFT
BASEMENT TOTAL - 2400.00 SFT
GROUND FLOOR COVERED AREA - 2400.00 SFT
A - 40'-0" x 66'-0" = 2400.00 SFT
G.FLOOR TOTAL - 2400.00 SFT
FIRST FLOOR COVERED AREA - 2400.00 SFT
A - 40'-0" x 66'-0" = 2400.00 SFT
DED-1 = 14'-0" x 5'-0" = 70.00 SFT
DED-2 = 2'-0" x 10'-3" = 20.50 SFT
F.FLOOR TOTAL - 2309.50 SFT
B.F + G.F + F.F = 2400.00 + 2400.00 + 2309.50 = 7109.50 SFT
MUMTY AREA = 267.75 SFT
GRAND TOTAL = 7377.25 SFT

SCHEDULE OF OPENING

D O O R S			
SNO	NAME	SIZE	SILL
01	D1	5'-0" X 7'-0"	
02	D2	3'-6" X 7'-0"	
03	D3	3'-0" X 7'-0"	
04	D4	2'-6" X 7'-0"	
W I N D O W S			
SNO	NAME	SIZE	SILL
01	W1	14'-0" X 6'-0"	
02	W2	13'-0" X 6'-0"	
03	W3	8'-0" X 6'-0"	
04	W4	7'-0" X 6'-0"	
05	W5	4'-0" X 6'-0"	
06	W6	2'-0" X 6'-0"	
07	W7	1'-6" X 6'-0"	
08	W8	8'-0" X 2'-0"	
09	V2	7'-0" X 2'-0"	
10	V3	4'-0" X 2'-0"	
11	V4	3'-0" X 2'-0"	
12	V5	2'-6" X 2'-0"	

CERTIFICATE

I, SOUNDNESS AND STABILITY OF THE STRUCTURE
2. CERTIFIED THAT THE SEWERAGE AND STORM WATER
SYSTEM ARE EFFECTIVELY BE CONNECTED TO C.D.A MAINS LINES

COMPLETION DRAWING

SCALE: AS SHOWN DATE: DRAWN BY: HARIHAR


COMPLETION PLAN OF A HOUSE ON

OWNER:-


OWNERS SIG

ARCHITECT'S SIG

ENGINEER'S SIG

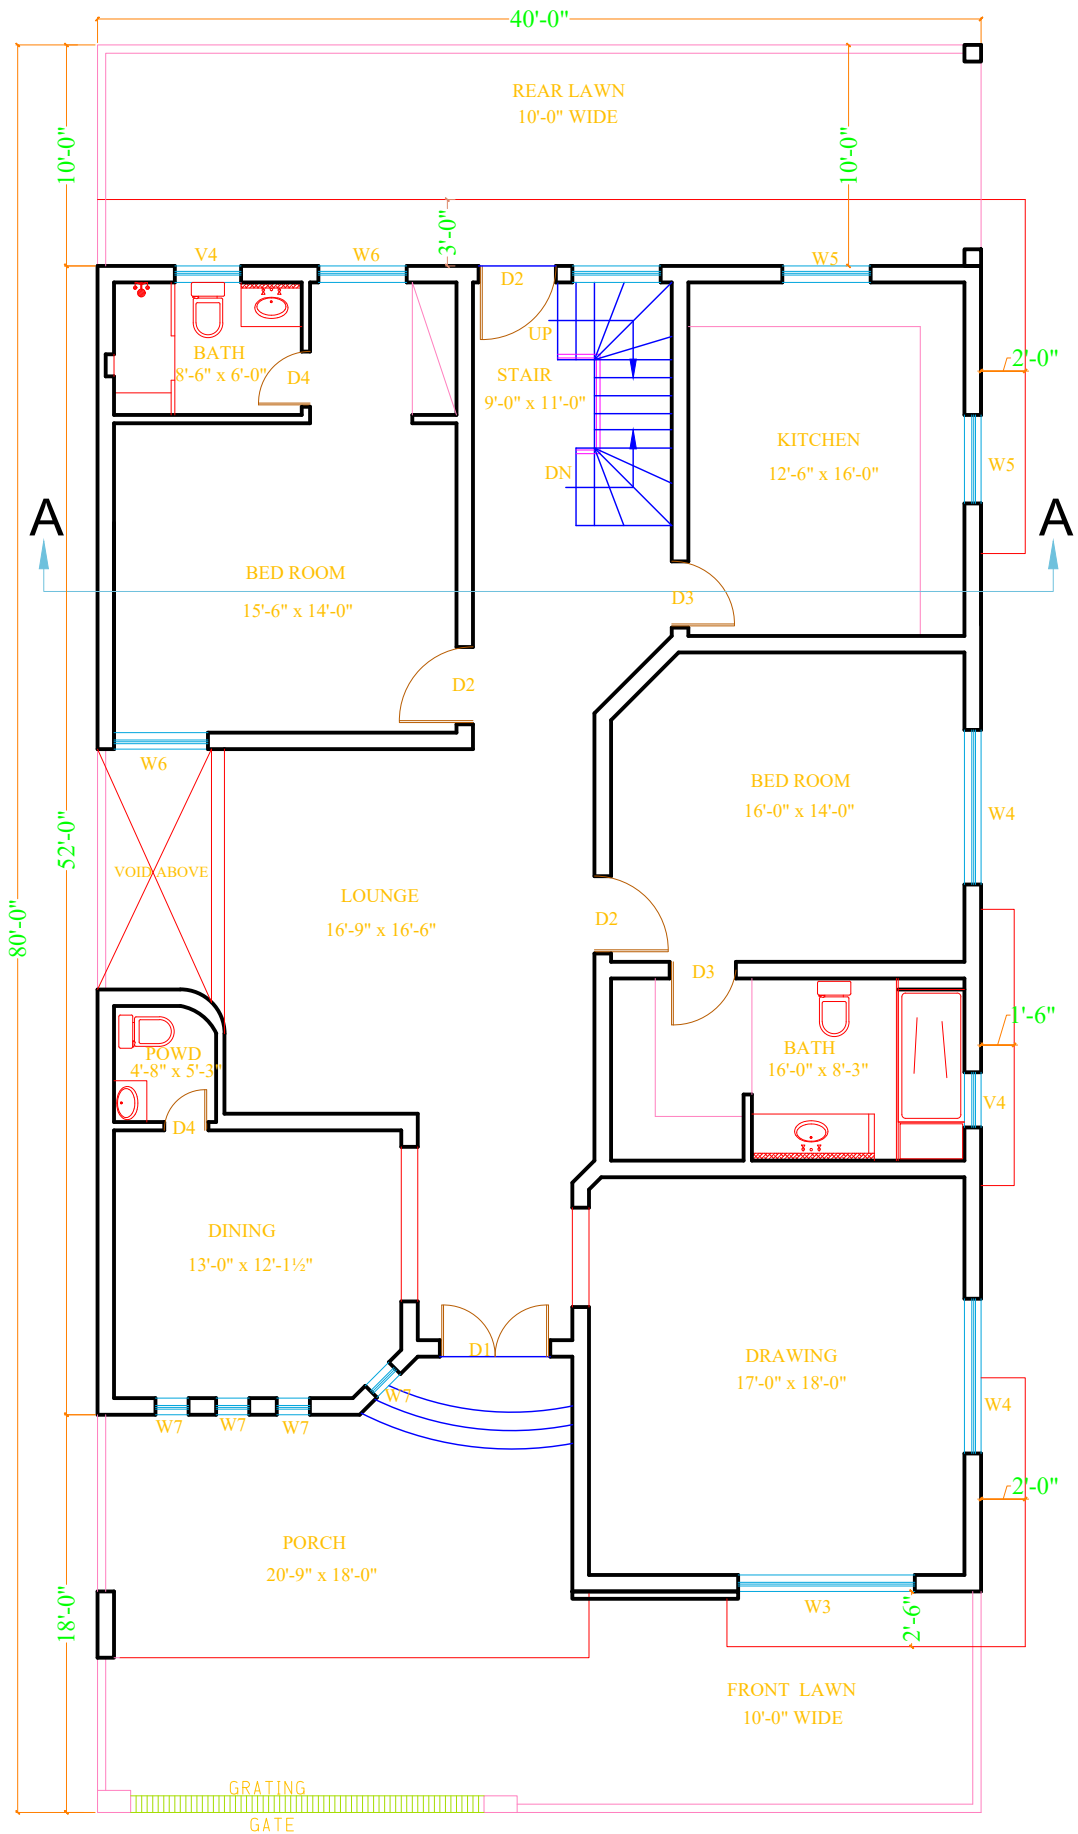


GROUND FLOOR PLAN

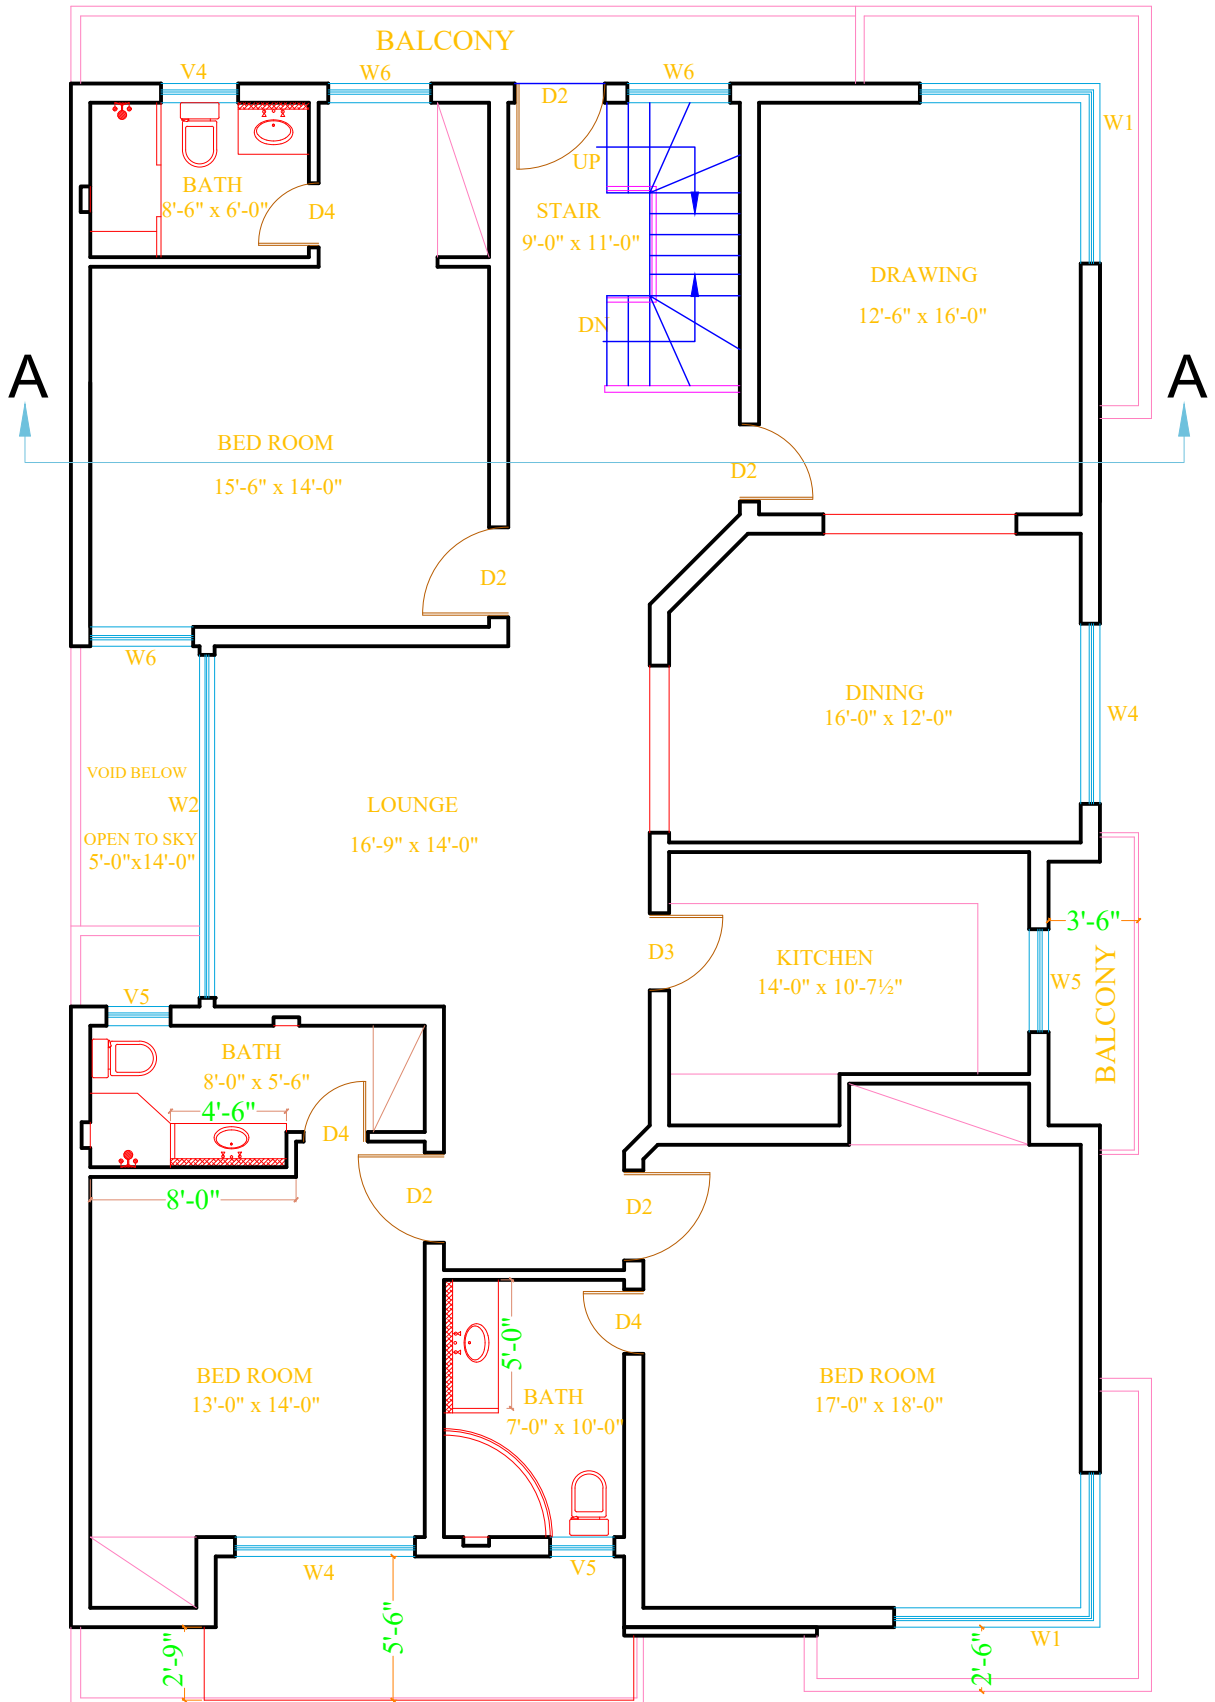

FIRST FLOOR PLAN



FRONT ELEVATION

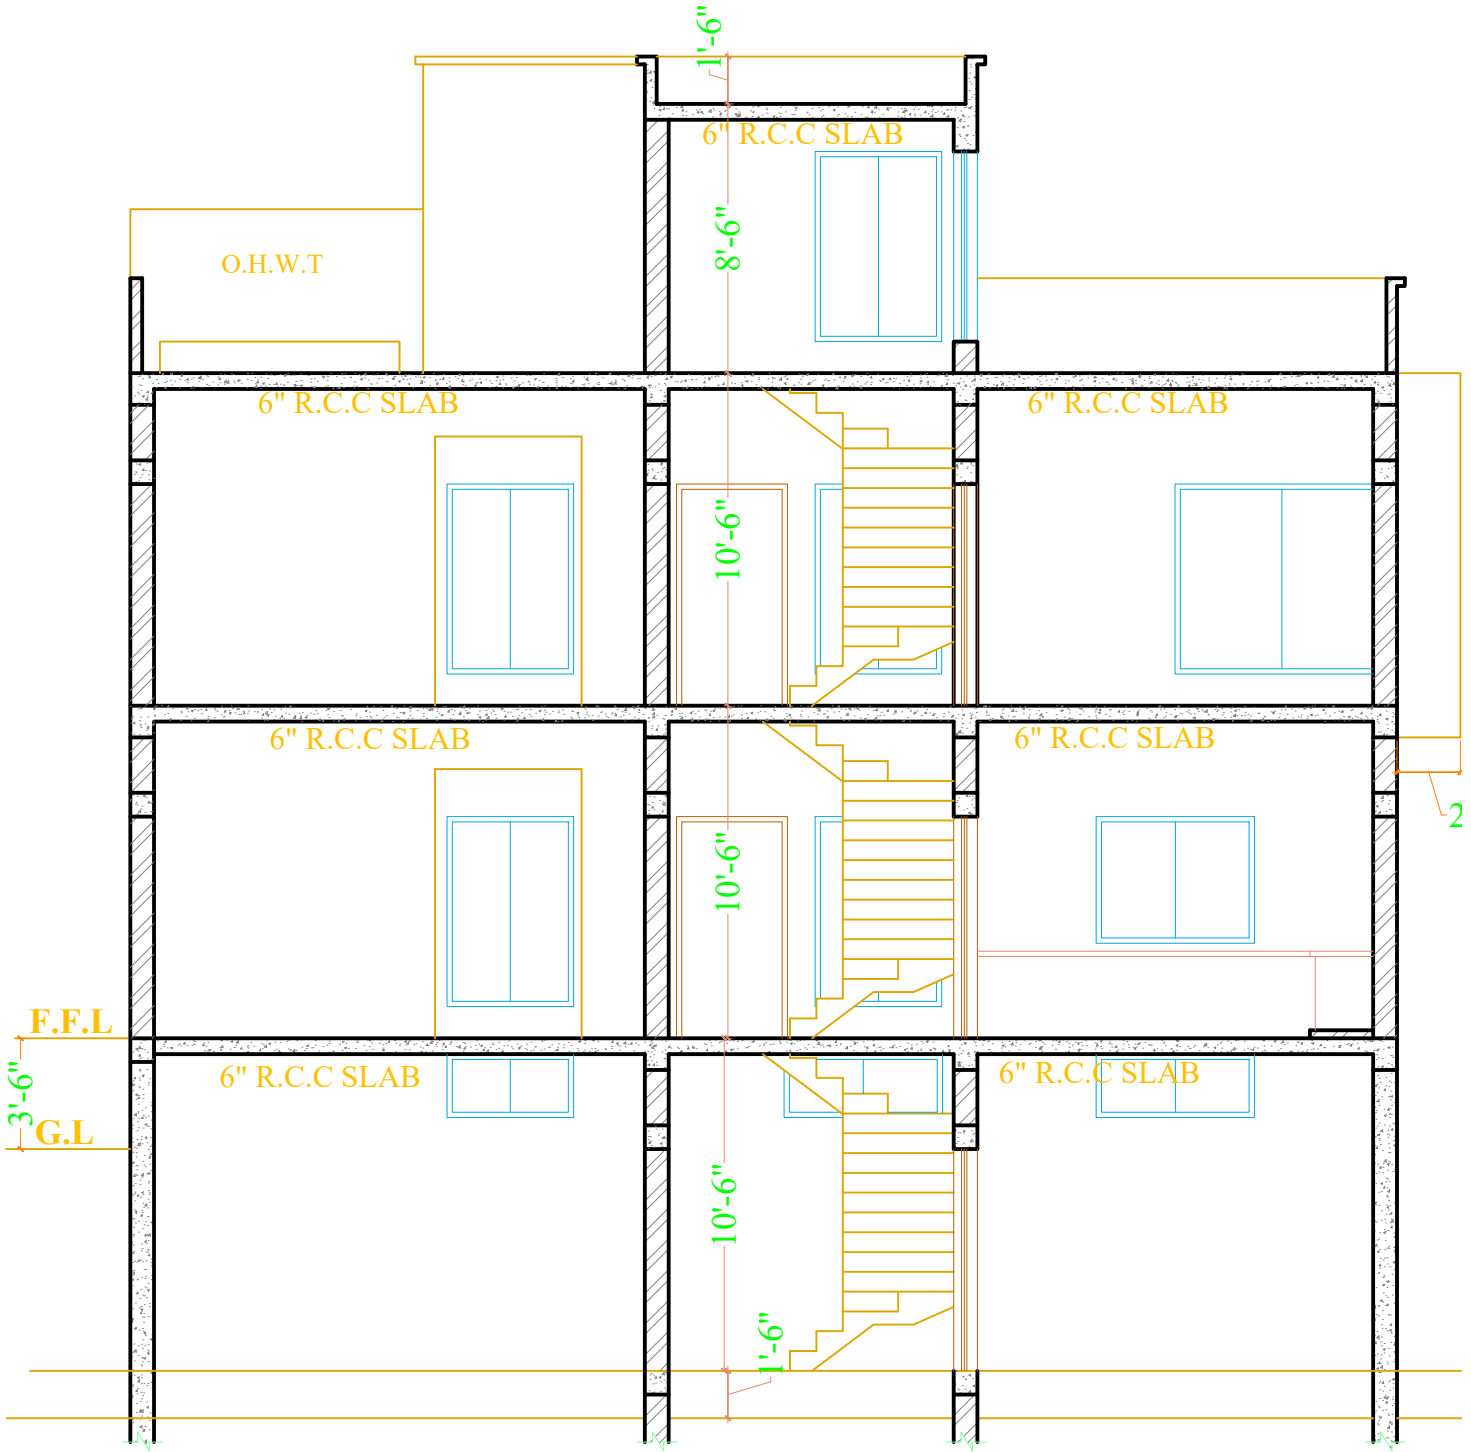

SECTION AT A-A